




FUEL OIL PIPING SECONDARY CONTAINMENT DETAIL NO SCALE

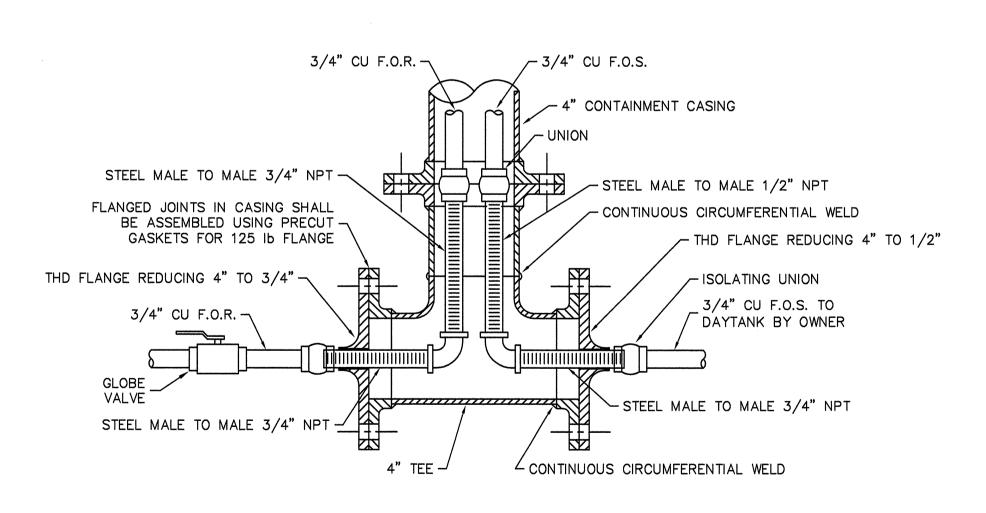

CONTAINMENT PIPING TERMINATION NO SCALE

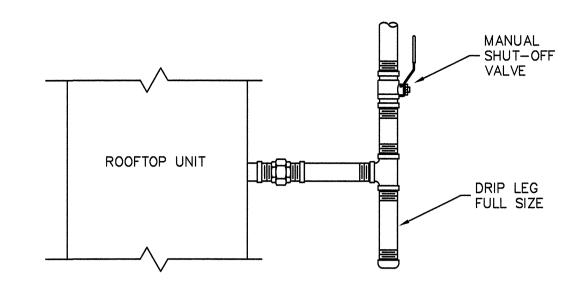

GAS CONNECTION DETAIL

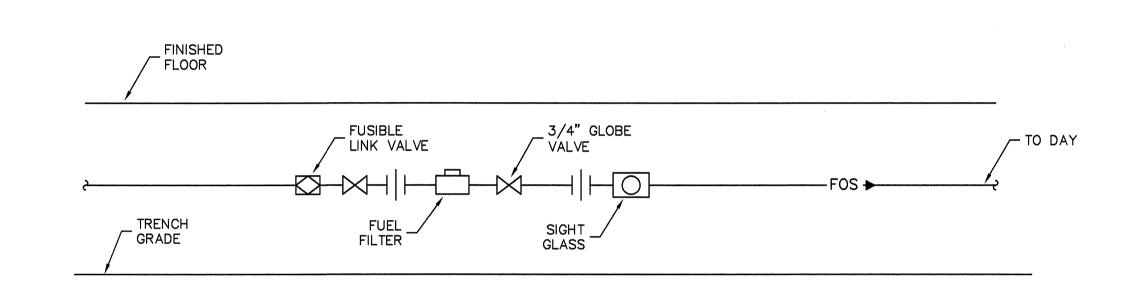

 ✓ VALVE MOUNTING DETAIL NO SCALE

APPROACHING TANK OVERFILL WHEN ALARM SOUNDS. STOP FUEL FLOW. PUSH BUTTON TO SILENCE ALARM

NOTE: 1" & 2" TALL BLACK LETTERS ON RED LAMICOID BACKGROUND.

250 GALLONS #2 DIESEL

TANK FUELING PROCEDURE

- 1. CLOSE CONTAINMENT DRAIN VALVE 2. FILL FUEL TANK
- 3. OPEN CONTAINMENT DRAIN VALVE

NOTE: 1" & 2" TALL BLACK LETTERS ON RED LAMICOID BACKGROUND.

I FILL PROCEDURE SIGN SCALE: 1-1/2" = 1'-0"



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CHECK APP'D DEPARTMENT OF TRANSPORTATION

FEDERAL AVIATION ADMINISTRATION MIKE MONRONEY AERONAUTICAL CENTER - OKLAHOMA CITY, OKLAHOMA PSL - POWER SERVICES LABORATORY

SAMUEL SHAUN SEXTON

PLUMBING DETAILS

Construction Work Request No: 09-018745 PREPARED BY APPROVED BY Rees Associates Jon Berkman

ISSUED BY OFFICE OF MAY 26, 2011 P-302 OFFICE OF
FACILITY MANAGEMENT
AMP-400

DRAWING NO.
08-008257 DWG WORK ORDER NO. 100111